\cnett\SmithGroup Companies Inc\PRJ — 10618 — General\CAD\C\Sheets\10618—C—001.dwg USER:cnett DATE:Aug, 17 2020 TIME: 10:05 am

ALGOMA CRESCENT BEACH

Algoma, Wisconsin AUGUST 4, 2020 ISSUED FOR CONSTRUCTION

Sheet List Table

Sheet Title Sheet Number **COVER SHEET** C-001 **EXISTING CONDITIONS PLAN** SITE PREPERATION AND EROSION CONTROL SITE PREPERATION AND EROSION CONTRIL DETAILS CD500 CS101 LAYOUT & MATERIALS PLAN CS500 SITE DETAILS CG100 **GRADING & UTILITY PLAN** CG500 UTILITY DETAILS LP100 PLANTING PLAN LP500 PLANTING DETAILS

Prepared for:

City of Algoma 416 FREMONT STREET ALGOMA, WI 54201 920.487.5203

Prepared by:

SMITHGROUP

44 EAST MIFFLIN STREET SUITE 500 MADISON, WI 53703 608.251.1177 www.smithgroupjjr.com



WS Packaging Group 👂



Statesant St.

N Water St.

North Water Bakery
St. Deli Home
N Water St.

Nearthous St.

Nearthous St.

States St.

States St.

North Water Bakery
St. Deli Home
N Water St.

North Water Bakery
St.

North Water St.

North Water Bakery
St.


North Water St.


Project


Location

PROJECT LOCATION MAP

Piggly Wiggly 🜍

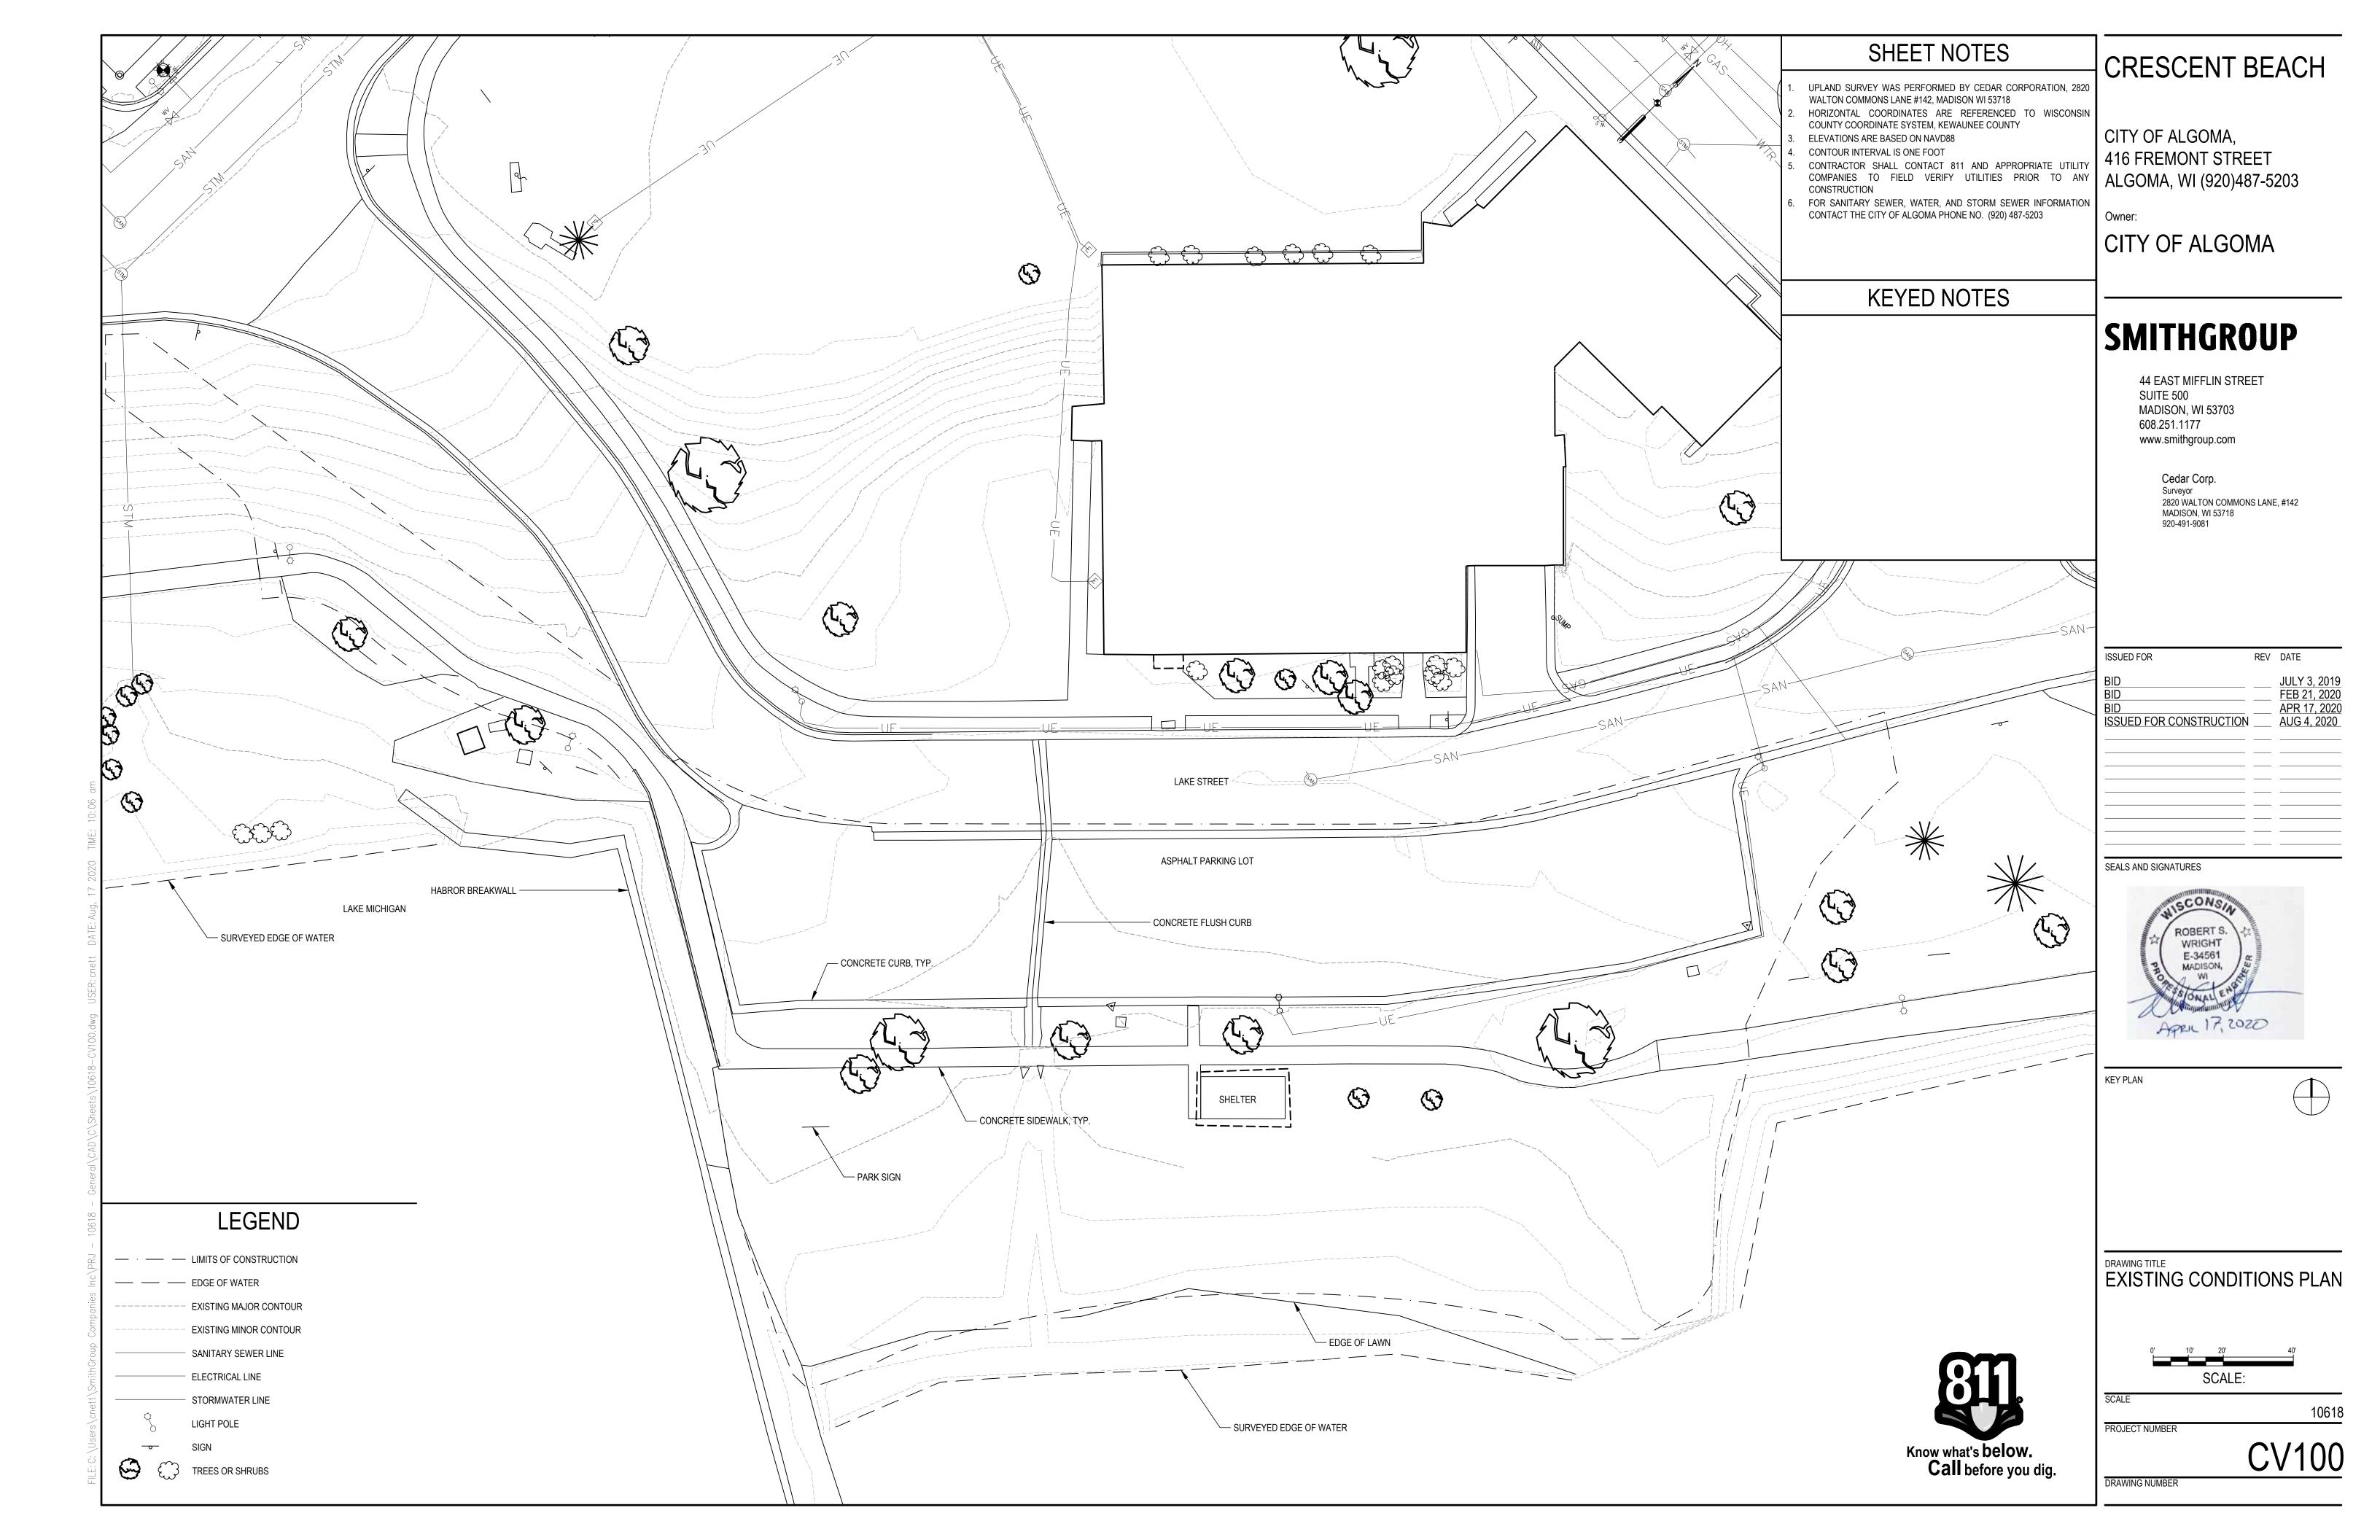

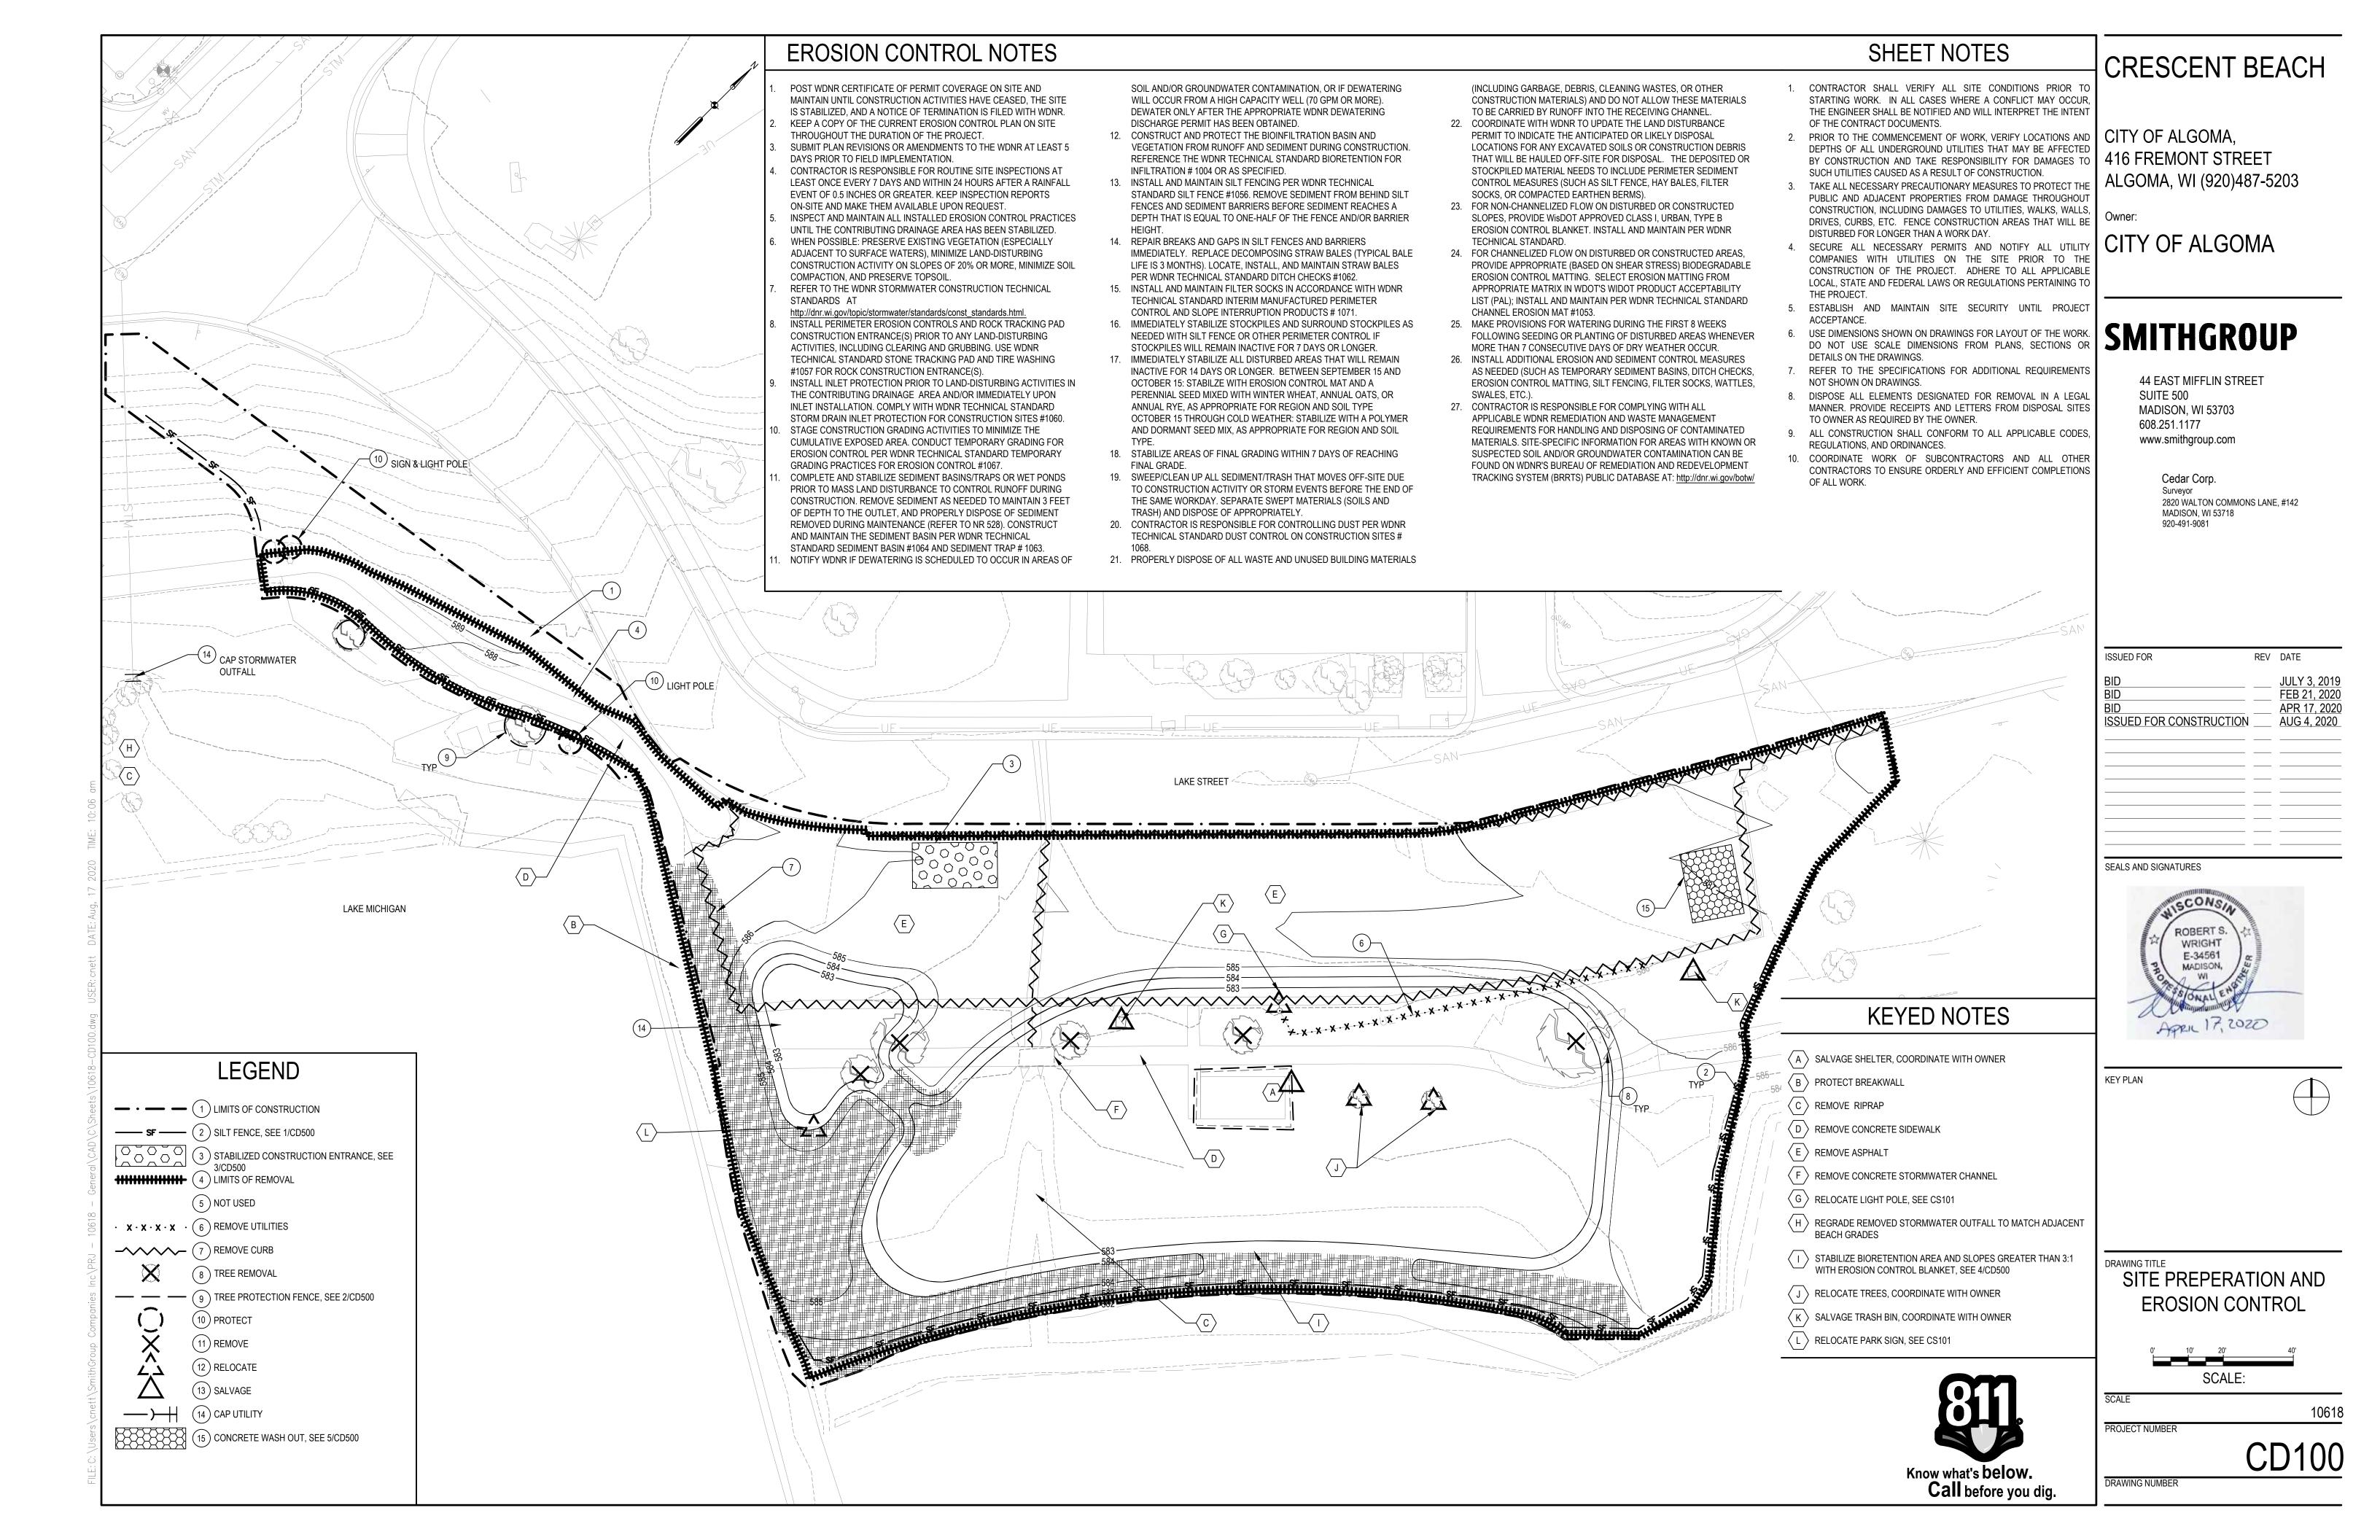

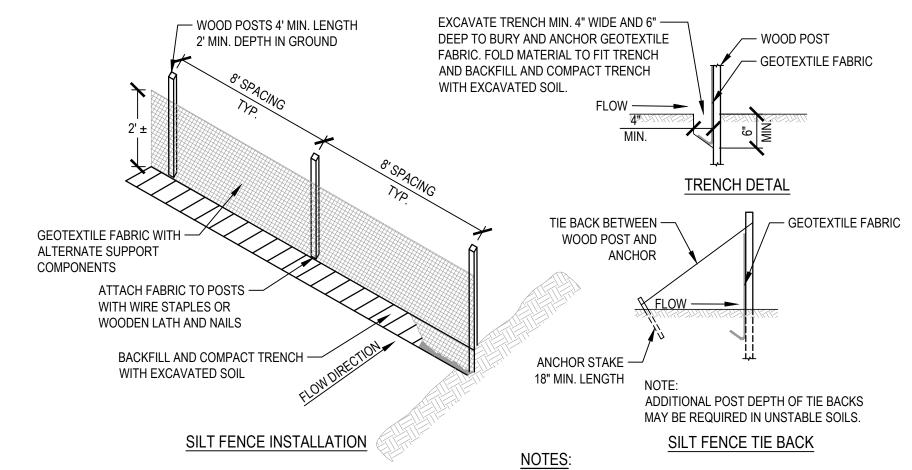

- DETAILS OF CONSTRUCTION, MATERIALS, AND WORKMANSHIP NOT SHOWN ON THIS DRAWING SHALL CONFORM TO THE PERTINENT REQUIREMENTS OF THE STANDARD SPECIFICATIONS AND THE APPLICATION SPECIAL PROVISIONS.
- WHEN POSSIBLE, THE SILT FENCE SHALL BE CONSTRUCTED IN AN ARC OR HORSESHOE SHAPE WITH THE ENDS POINTING UP SLOPE TO MAXIMIZE BOTH STRENGTH AND EFFECTIVENESS.
- EXCAVATE TRENCH MINIMUM 4-INCH WIDE AND 6-INCH DEEP TO BURY AND ANCHOR THE GEOTEXTILE FABRIC. FOLD MATERIAL TO FIT TRENCH AND BACKFILL AND COMPACT TRENCH WITH EXCAVATED SOIL.
- GEOTEXTILE FABRIC SHALL BE REINFORCED WITH AN INDUSTRIAL POLYPROPYLENE NETTING WITH A MAXIMUM MESH SPACING OF 3/4-INCH OR EQUAL. A HEAVY DUTY NYLON TOP SUPPORT CORD OR EQUIVALENT IS REQUIRED.

- CHAIN LINK FENCE **EQUAL** CRITICAL ROOT CRR (FEET) = RADIUS (CRR)

TREE PROTECTION FENCE

DBH (INCHES) x 1.5

- ALL TREES SHOWN TO BE RETAINED WITHIN THE LIMITS OF CONSTRUCTION ON THE PLANS SHALL BE PROTECTED DURING CONSTRUCTION WITH CHAINLINK FENCING.
- TREE PROTECTION FENCES SHALL BE INSTALLED PRIOR TO THE COMMENCEMENT OF ANY DEMOLITION WORK (CLEARING, GRUBBING, OR GRADING) AND SHALL BE MAINTAINED THROUGHOUT ALL PHASES OF THE CONSTRUCTION PROJECT. NO CONSTRUCTION MATERIALS, EQUIPMENT, OR SUPPLIES MAY BE STORED IN THE TREE PROTECTION
- 3. TRUNK DIAMETER AT BREAST HEIGHT (DBH) MEASURED AT 4.5' ABOVE THE GROUND.
- 4. TREE PROTECTION FENCE POSTS 8' O.C. MAX.

3" CLEAR STONE - PLACE STONE ON GEOTEXTILE FABRIC

A CONSTRUCTION ENTRANCE SHALL BE INSTALLED AT THE LOCATIONS SHOWN ON THE PLAN TO PREVENT TRACKING OF SOIL ONTO EXISTING STREET AND ROADS. THE CONTRACTOR SHALL CLEAN, SCRAPE, OR SWEEP ALL TRACKED SOIL FROM SAID ROADWAYS AT THE END OF EACH WORK DAY AND AS DIRECTED BY THE ENGINEER.

STABILIZED CONSTRUCTION ENTRANCE

416 FREMONT STREET ALGOMA, WI (920)487-5203

CITY OF ALGOMA,

CRESCENT BEACH

Owner:

CITY OF ALGOMA


SMITHGROUP

44 EAST MIFFLIN STREET SUITE 500 MADISON, WI 53703 608.251.1177 www.smithgroup.com

Cedar Corp. Surveyor 2820 WALTON COMMONS LANE, #142 MADISON, WI 53718 920-491-9081

ISSUED FOR REV DATE JULY 3, 2019 FEB 21, 2020 APR 17, 2020 ISSUED FOR CONSTRUCTION <u>AUG 4, 2020</u>

SEALS AND SIGNATURES

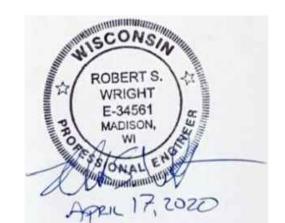

KEY PLAN

SITE PREPERATION AND **EROSION CONTRIL DETAILS**

SCALE PROJECT NUMBER

DRAWING NUMBER

∕-NO. 11 GA. OR LARGER DIAMETER WIRE OR EQUIVALENT JUNCTION SLOT (SOD ONLY) DETAIL OF TYPICAL STAPLE *-6" MIN FOR FIRM SOILS -8" MIN WHERE BOTH SOD AND MATS ARE BEING USED AT BEGINNING AND END OF EROSION MAT (SEED AND SOD) -12" MIN FOR LOOSE SOILS (SEED AND SOD) 1. DETAILS OF CONSTRUCTION, MATERIALS AND WORKMANSHIP NOT SHOWN ON THIS DRAWING SHALL CONFORM TO THE PERTINENT REQUIREMENTS OF THE STANDARD SPECIFICATIONS AND THE APPLICABLE SPECIAL PROVISIONS. 2. VARIATIONS IN THE DIMENSIONS OR MATERIALS SHOWN HEREON SHALL BE PERMITTED IF THEY PROVIDE EQUIVALENT

- PROTECTION AND MATERIAL STRENGTH AND IF PRIOR APPROVAL OF THE ENGINEER IS OBTAINED.
- 3. LAP JOINTS SHALL NOT BE PLACED IN THE BOTTOM OF V-SHAPED DITCHES. 4. JUNCTION SLOTS ON ADJACENT STRIPS OF MATTING SHALL BE STAGGERED A MINIMUM OF 4 FEET APART.
- 5. EDGES OF THE EROSION MAT SHALL BE IMPRESSED IN THE SOIL. 6. EROSION MAT SHALL BE MEASURED AND PAID FOR IN ACCORDANCE WITH THE STANDARD SPECIFICATIONS.

EROSION MAT OVER SOD

SILT FENCE

- ONLY JUTE FABRIC WILL BE PERMITTED OVER SOD.
- WOOD STAKES FOR SOD MAY BE OMITTED IF THE EXISTING SLOPE AND SOIL CONDITIONS SO PERMIT.
- THE WIDTH OF EROSION MAT SHALL ALWAYS EQUAL THE SOD WIDTH.
- SOD STRIPS MAY BE PLACED EITHER LONGITUDINALLY OR TRANSVERSELY TO THE FLOW LINE OF THE DITCH.

EROSION MAT OVER SEEDING

EROSION CONTROL BLANKET

- JUNCTION OR ANCHOR SLOTS SHALL BE AT MINIMUM INTERVALS OF 100 FEET ON GRADES UP TO AND INCLUDING 3

PERCENT, AND 50 FEET ON GRADES EXCEEDING 3 PERCENT.

CONCRETE WASH OUT

COMPACTED SUBGRADE

- TWÔ MÉTAL OR WOOD STAKES PER BALE/

SŤRAW BALE, STAKEŠ SECUŘELÝ

ŠĘCURE POĽYEŤHYĽENĚ TO STŘAW BALE WITH PINS OR STAPLES

— METAL OR WOOD STAKE

- SECURE POLYETHYLENE TO STRAW

EXTEND OVER STRAW BALES. SECURE WITH PINS OR STAPLES.

10 MM THICK POLYETHYLENE LINING TO —

BALE WITH PINS OR STAPLES


WASHOUT BASIN SHALL BE


TRENCHED 4" INTO SUBGRADE

- STRAW BALE, STAKED SECURELY

- 10 MW THICK ÞOLYETHYLENE LINING 🛶 TO EXTEND OVER STRAW BALES. SECURE WITH PINS OR STAPLES.

> BIND STRAW BALES — PARALLEL TO GROUND

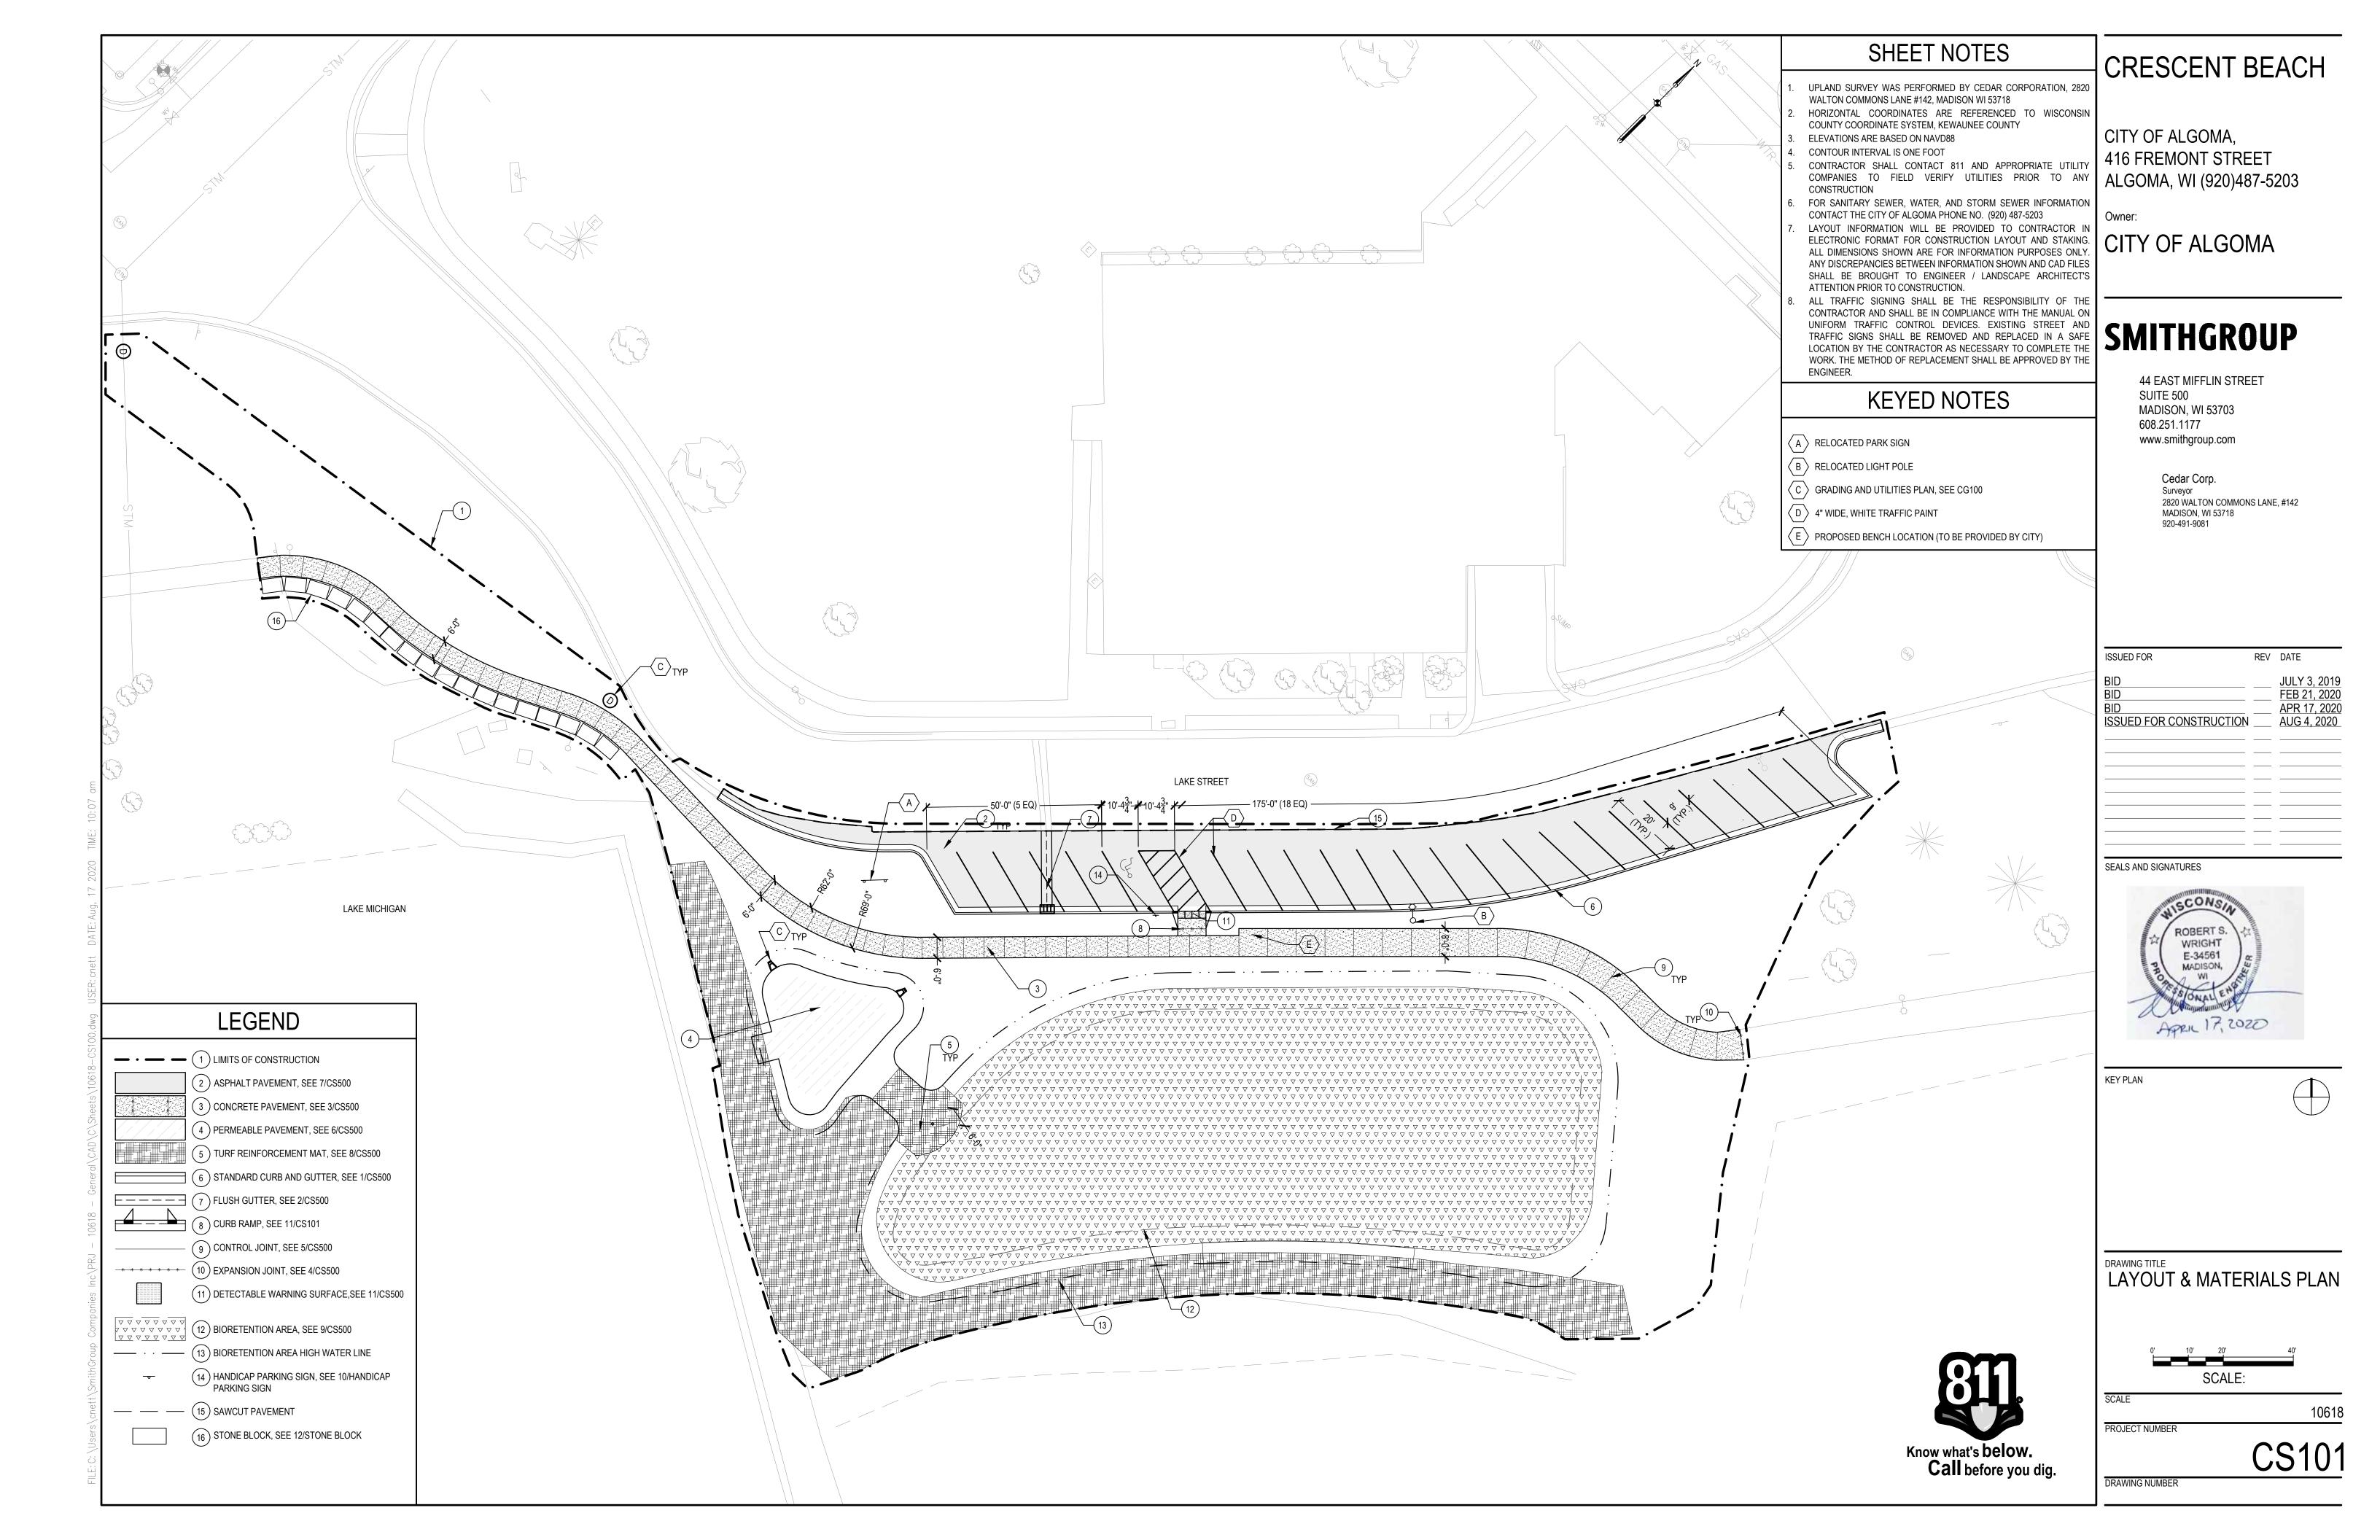

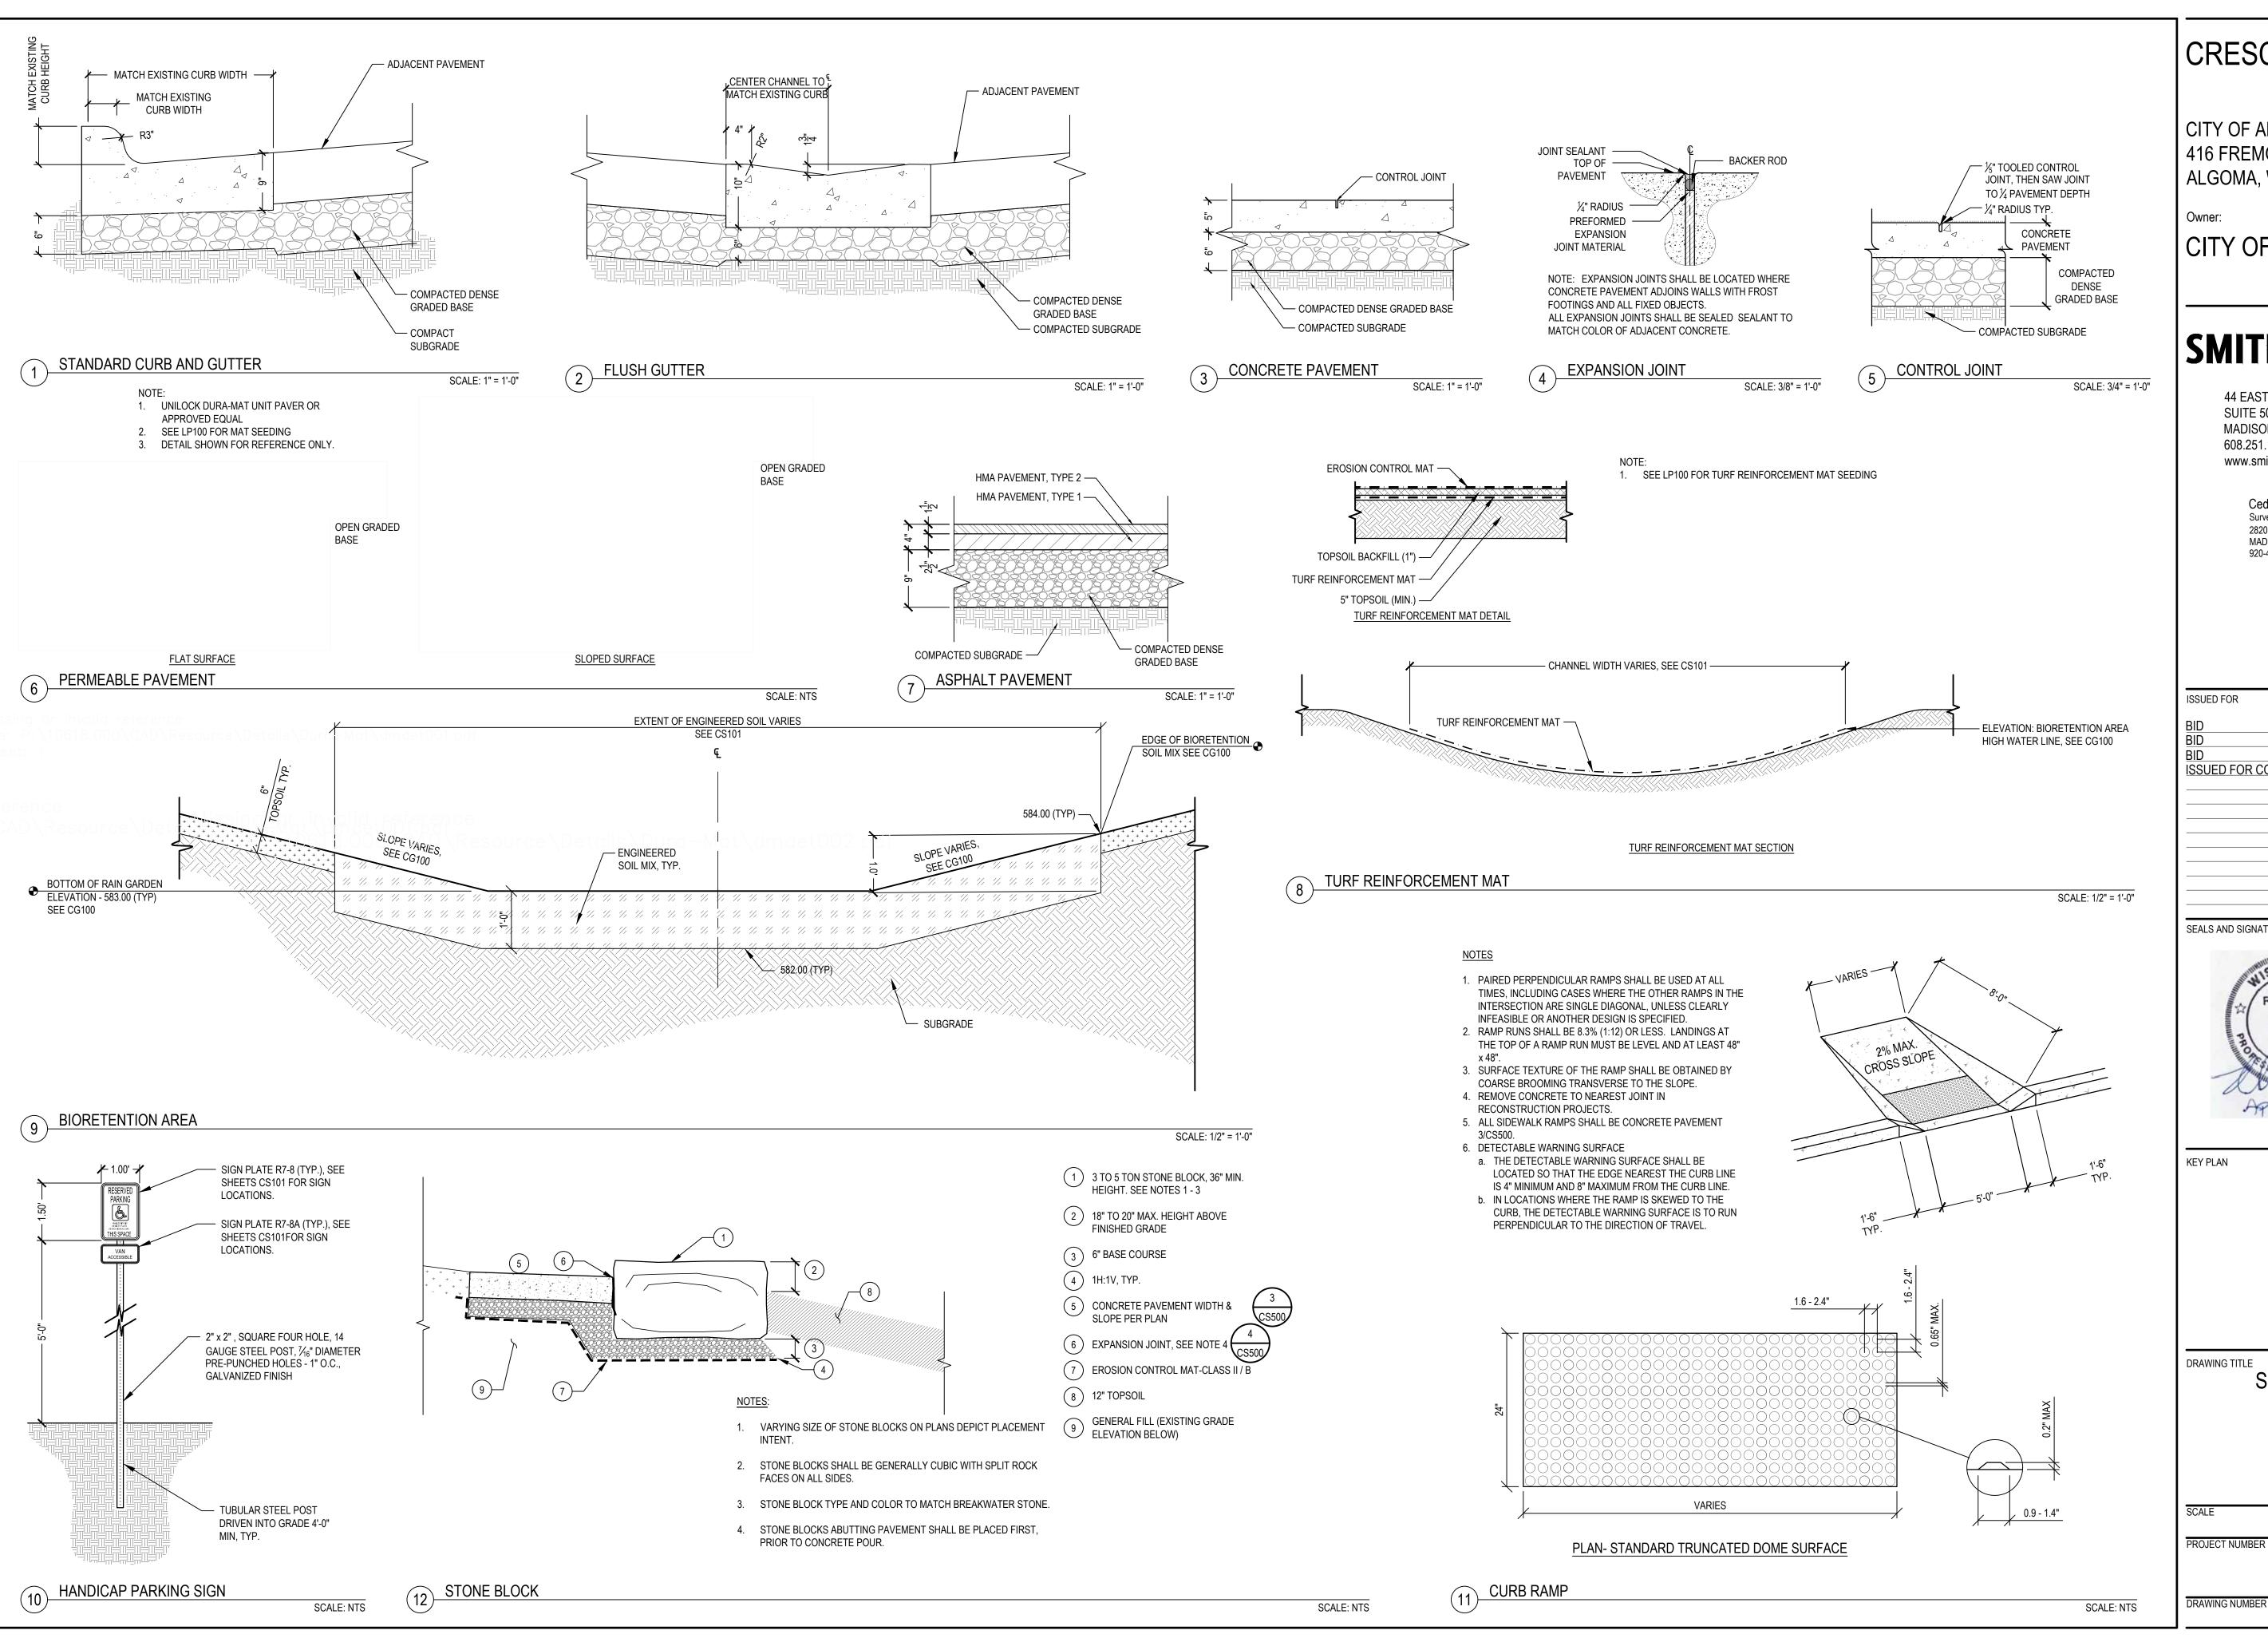

CRESCENT BEACH

CITY OF ALGOMA, 416 FREMONT STREET ALGOMA, WI (920)487-5203

Owner:

CITY OF ALGOMA


SMITHGROUP

44 EAST MIFFLIN STREET SUITE 500 MADISON, WI 53703 608.251.1177 www.smithgroup.com

> Cedar Corp. Surveyor 2820 WALTON COMMONS LANE, #142 MADISON, WI 53718 920-491-9081

ISSUED FOR	REV	DATE
BID BID BID ISSUED FOR CONSTRUCTION		JULY 3, 2019 FEB 21, 2020 APR 17, 2020 AUG 4, 2020

SEALS AND SIGNATURES

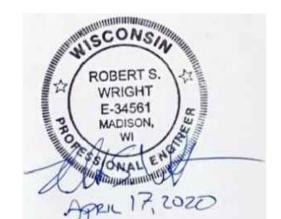

KEY PLAN





DRAWING TITLE


SITE DETAILS


SCALE

DRAWING NUMBER

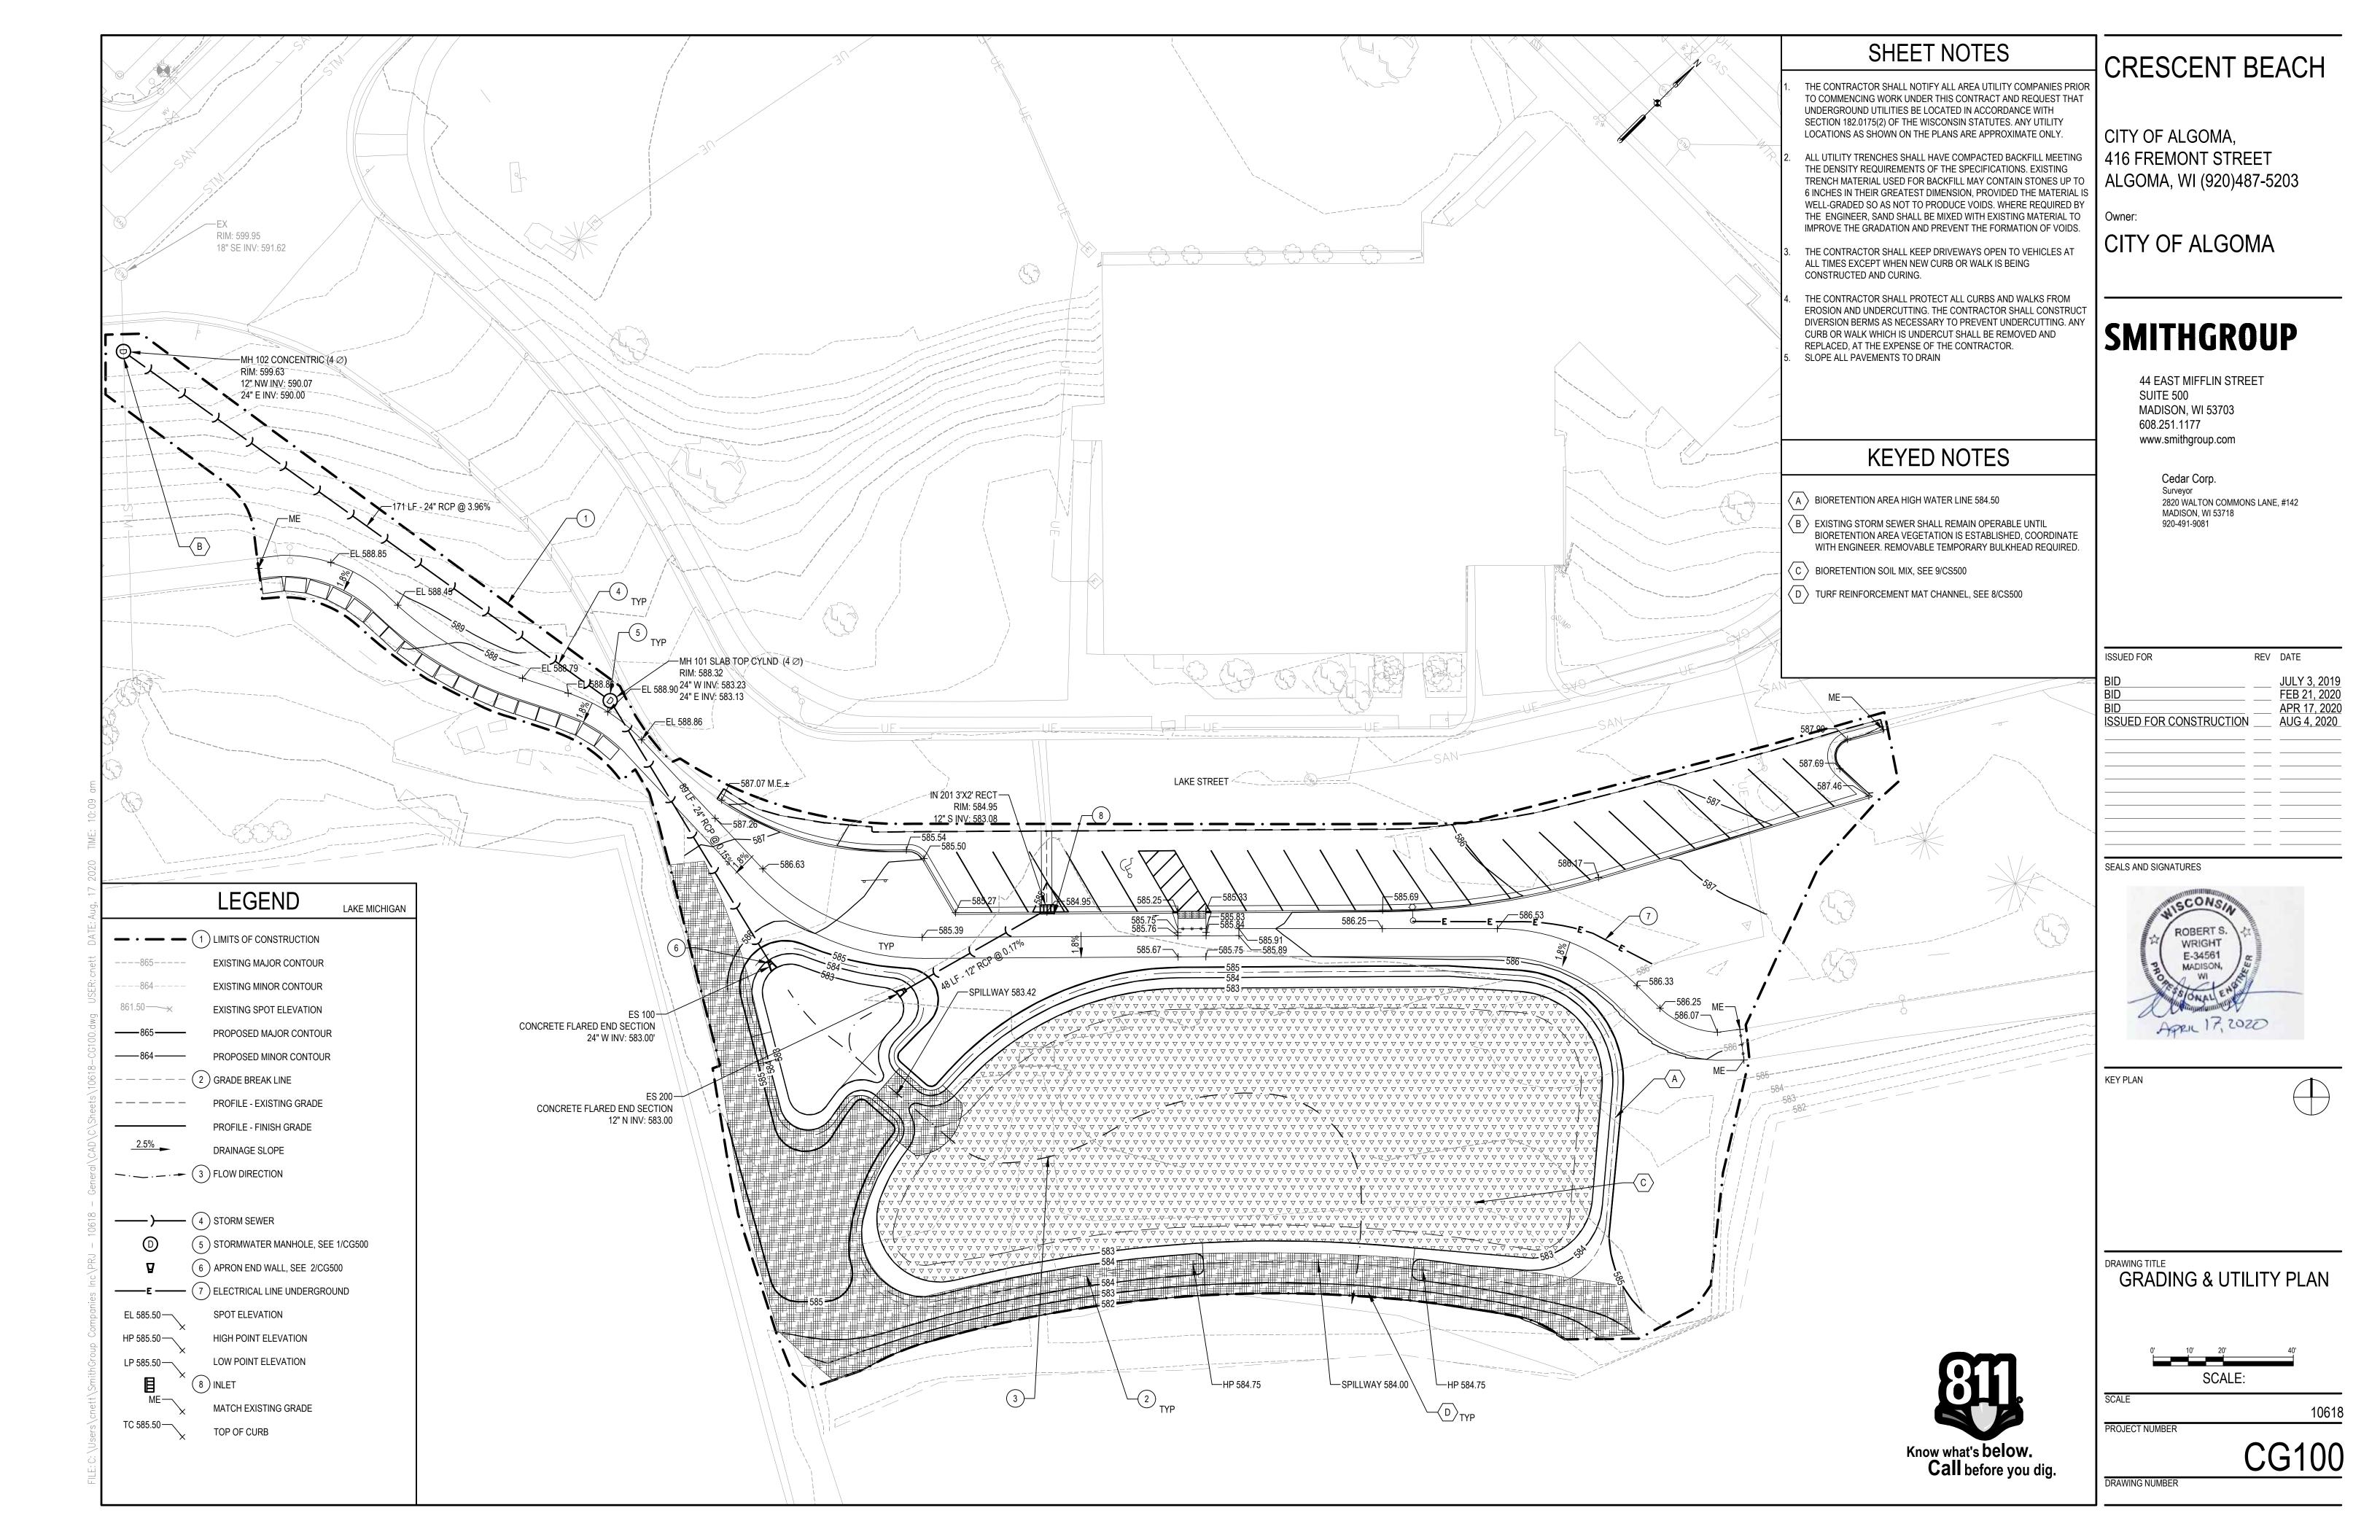

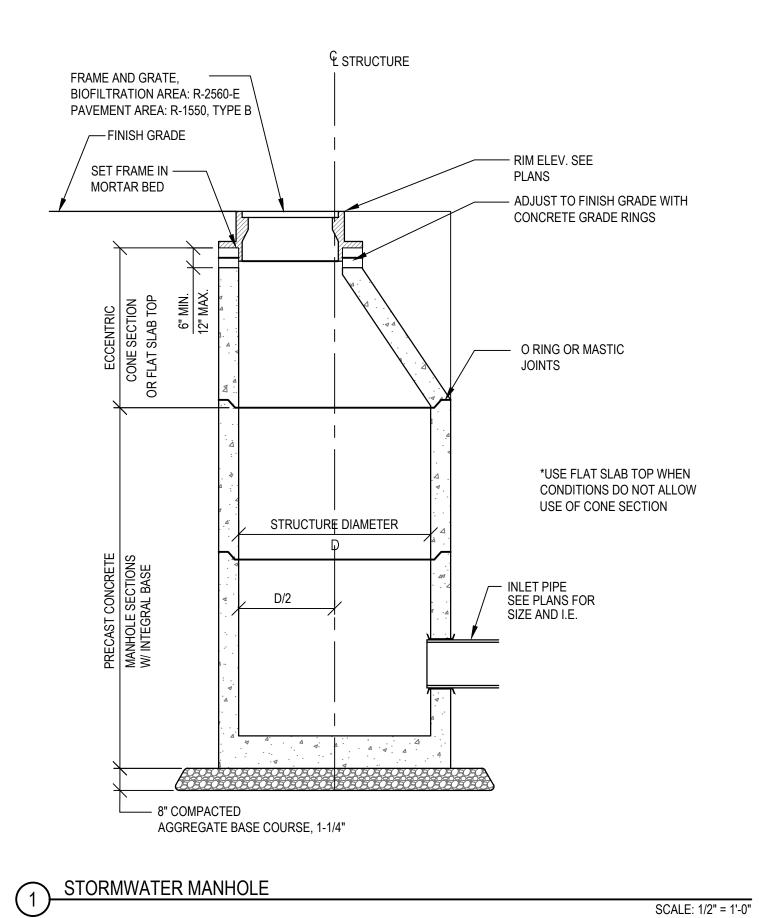

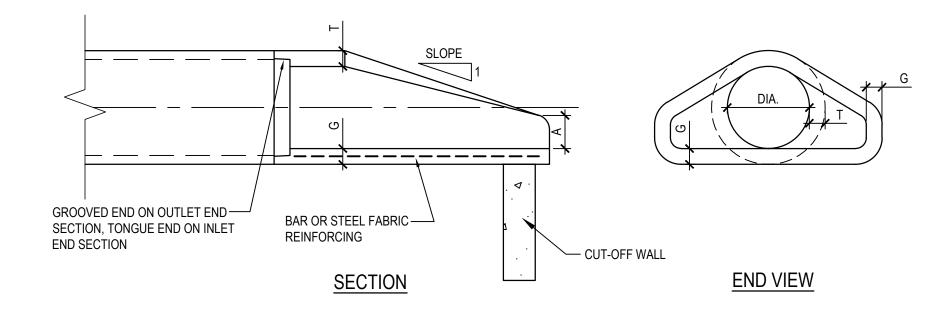

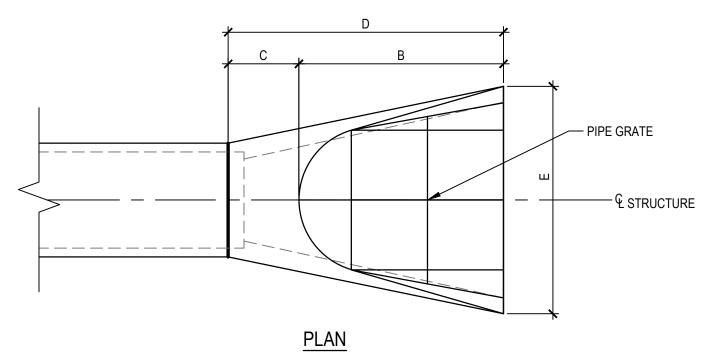

END WALL DIMENSION TABLE								
DIA	Т	A	В	С	D	E	G	APPROX. SLOPE
12"	2"	4"	24"	48 7/8"	72 7/8"	24"	2"	3H:1V
24"	3"	9-1/2"	43-1/2"	30"	73-1/2"	48"	3"	3H:1V
LARGER DIA TO BE PROVIDED BY MANUFACTURER AND VERIFIED BY ENGINEER								

NOTE:

 BEDDING SHALL BE PER DETAILS HEREIN.
 JOINT TIES SHALL BE REQUIRED FOR ALL PIPES 18" AND GREATER. SEE SPECIFICATIONS.

3. 6-INCH CONCRETE APRON ENDWALL FOR UNDERDRAIN SHALL CONFORM TO WISDOT STANDARD SPECIFICATION SECTION 612 AND STANDARD DETAIL DRAWING 8F6: REINFORCED CONCRETE APRON ENDWALL FOR PIPE UNDERDRAIN.

APRON END WALL

SCALE: NTS

CRESCENT BEACH

CITY OF ALGOMA, 416 FREMONT STREET ALGOMA, WI (920)487-5203

Owner:

CITY OF ALGOMA

SMITHGROUP

44 EAST MIFFLIN STREET SUITE 500 MADISON, WI 53703 608.251.1177 www.smithgroup.com

> Cedar Corp. Surveyor 2820 WALTON COMMONS LANE, #142 MADISON, WI 53718 920-491-9081

ISSUED FOR	REV	DATE
BID BID ISSUED FOR CONSTRUCTION		JULY 3, 20 FEB 21, 20 APR 17, 20 AUG 4, 202

SEALS AND SIGNATURES



KEY PLAN

WAWING TITLE


UTILITY DETAILS


PROJECT NUMBER


CG500

DRAWING NUMBER

S — GENETALYCADYCYSNEETSYNOONO-CGSUUSAMY USER.CHETL DATE.AUG, 17 ZUZU HME. 10.U3 UNI

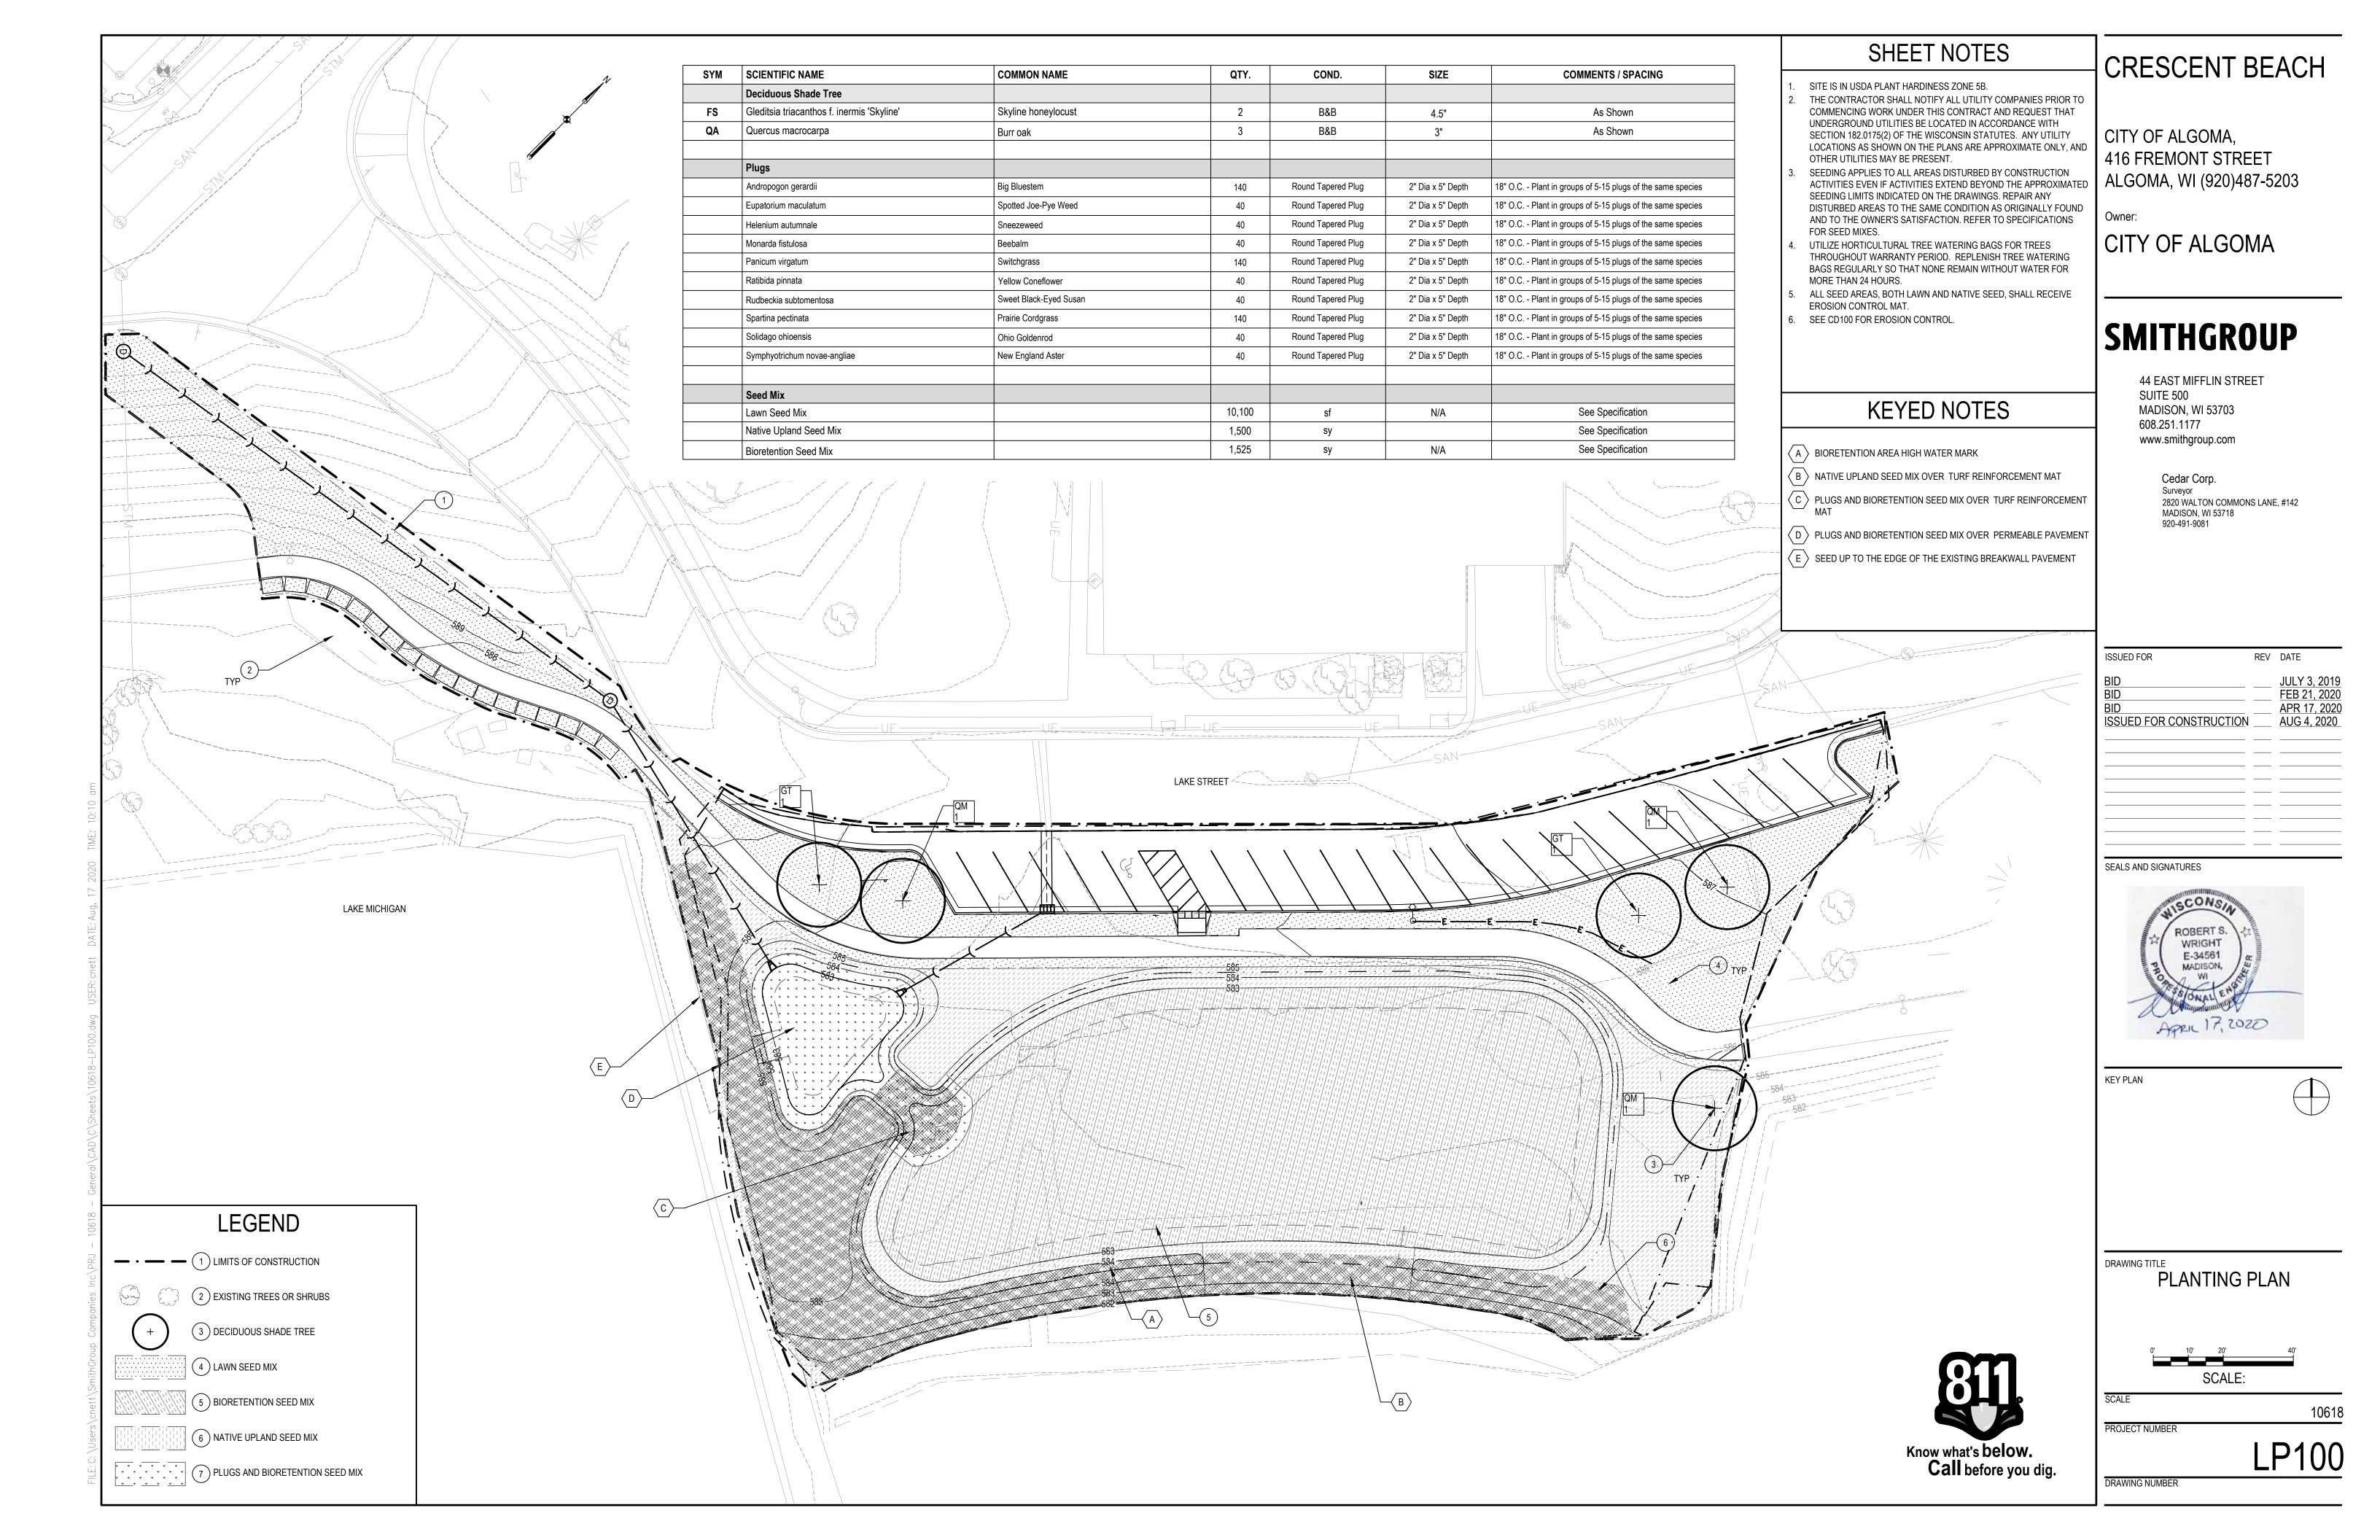

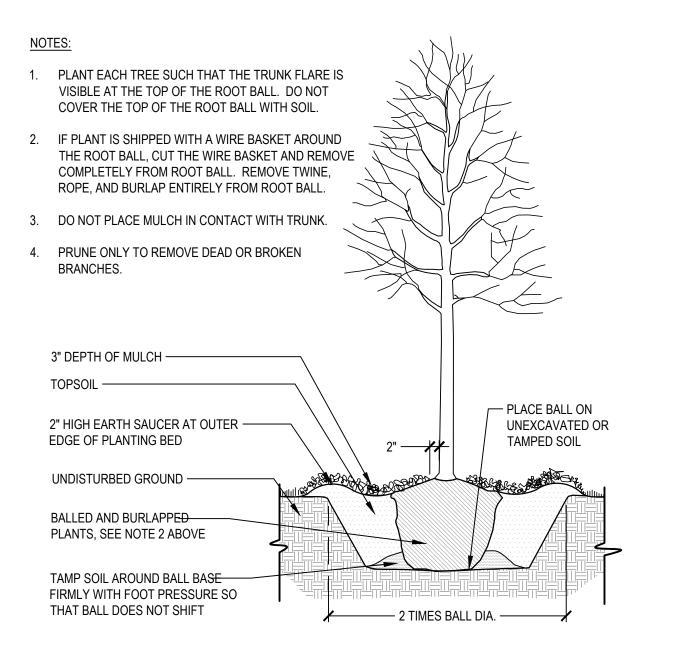

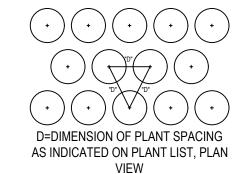

2 PLANT SPACING DETAIL

SCALE: N

1 DECIDUOUS TREE PLANTING

SCALE: NTS

CRESCENT BEACH

CITY OF ALGOMA, 416 FREMONT STREET ALGOMA, WI (920)487-5203

Owner:

CITY OF ALGOMA


SMITHGROUP

44 EAST MIFFLIN STREET SUITE 500 MADISON, WI 53703 608.251.1177 www.smithgroup.com

> Cedar Corp. Surveyor 2820 WALTON COMMONS LANE, #142 MADISON, WI 53718 920-491-9081

ISSUED FOR	REV	DATE
BID BID BID ISSUED FOR CONSTRUCTION	 	JULY 3, 2019 FEB 21, 2020 APR 17, 2020 AUG 4, 2020

SEALS AND SIGNATURES

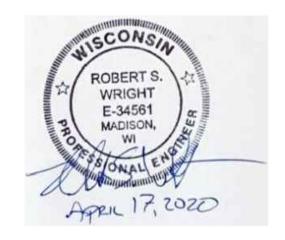

KEY PLAN

DRAWING TITLE
PLANTING DETAILS

SCALE 106
PROJECT NUMBER

LP500

DRAWING NUMBER